Drain: MERRIMAC ORAIN	Drain #: 278			
Improvement/Arm: MERRIMAC SECTION 3				
Operator: Joh	Date: 2-11-04			
Drain Classification: Urban/Rural	ear installed: /99			

GIS Drain Input Checklist

- Pull Source Documents for Scanning
- Digitize & Attribute Tile Drains
- Digitize & Attribute Storm Drains
- Digitize & Attribute SSD
- Digitize & Attribute Open Ditch
- Stamp Plans
- Sum drain lengths & Validate
- Enter Improvements into Posse
- Enter Drain Age into Posse
- Sum drain length for Watershed in Posse
- Check Database entries for errors

- graf 2-11____ NIA apr 2-11 -JAZ-11

NA

JH 2-11 <u>94.2-11</u>


QZZ-11

1-3-1 1-3-1 12-11

<u>Gasb 34 Footages for Historical Cost</u> <u>Drain Length Log</u>

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Drain Type:	Size:	Length SURVEYED REDRT	(DB Query)	Reconcile	Price:	Cost:
SSD	6"	5,680'	5,680'	Ø	# 2,00	1/360.00
RCP	/2"	1,251'	1,252'	+1	7.25	9,077.00
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	18"	551'	551'	ø	10,50	578550
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Drain-Improvement: MERRIMAL ORAN - MERRIMAC -SECTION 3

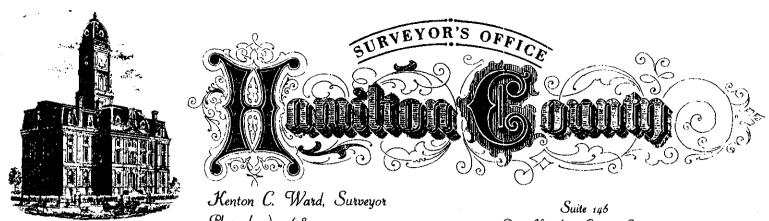

Phone (317) 776-8495 Fax (317) 776-9628

One Hamilton County Square Noblesville, Indiana 46060-2230

February 3, 1997

TO: HAMILTON COUNTY DRAINAGE BOARD

RE: Merrimac Drain-Section 3 Arm

Attached is a petition, plans, non-enforcement request, calculations, quantity summary and assessment roll for the <u>Section</u> <u>3 Arm, Merrimac Drain.</u> I have reviewed the submittals and petition and have found each to be in proper form.

I have made a personal inspection of the land described in the petition. Upon doing so, I believe that the drain is practicable; will improve the public health; benefit a public highway and be of public utility; and that the costs, damages and expenses of the proposed drain will probably be less than the benefits accruing to the owners of land likely to be benefited. The drain will consist of the following:

6^{n}	SSD	6,453	feet	18"	RCP	544	feet
12"	RCP	1,255	feet	24"	RCP	566	feet
15"	\mathbf{RCP}	39	feet				

The total length of the drain will be 8,857 feet.

The retention pond (lake) located in the Common Area at the n tear of Lots 43 to 48 is to be considered part of the regulated drain. This is being constructed as a portion of a Regional Detention Facility per the report by Schneider Engineers, dated February 26, 1996, which was the basis of my report to the Board, dated October 1, 1996. This was approved by the Board on October 28, 1996. The Board will ensure that the storage volume for which the lake was designed will be retained. Thereby, allowing no fill or easement encroachments. However, the length is not included in the above listed lengths since it is part of the Osborn and Collins #2 Drain. Maintenance for the lake shall be under Page #2

Merrimac Drain until such time the Osborn-Collins #2 Drain is placed on maintenance. The two (2) culverts under 146 Street are not to be considered part of this drain.

The subsurface drains (SSD) to be part of the regulated drain are those located under the curbs. Only the main SSD line which are located within the Right-of-Way are to be maintained as regulated drain. Laterals for individual lots will not be considered part of the regulated drain.

The average lot size for this section is 0.4 acre. The common area for the development is 4.67 acres. I recommend the maintenance for the pond be set at \$350.00, until such time the Osborn-Collins #2 Drain is placed on maintenance. At the time the assessment for the common area for the Merrimac Drain be set at \$30.00. I have reviewed the plans and believe the drain will benefit each of the lots equally and benefit the common area a greater amount at this time. Therefore, I recommend each lot be assessed equally. I also believe that no damages will result to landowners by the Construction of this drain. I recommend a maintenance assessment of \$30.00 per lot, \$5.00 per acre for roadways, with a \$30.00 minimum. With this assessment the total annual assessment for this section will be $\frac{1635.45}{1635.45}$.

Parcels assessed for this drain may be assessed for the Osborn-Collins or the Williams Creek Drain at sometime in the future.

I believe this proposed drain meets the requirements for Urban Drain Classification as set out in IC 36-9-27-67 to 69. Therefore, this drain shall be designated as an Urban Drain.

I recommend that upon approval of the above proposed drain the Board also approve the attached non-enforcement request. This request is for the reduction of the regulated drain easement to those easement widths as shown on the secondary plat for <u>Merrimac</u> <u>Section 3</u>, as recorded in the office of the Hamilton County Recorder.

I recommend the Board set a hearing for this proposed drain for March, 1997.

TAN L

Kenton⁷C. Ward Hamilton County Surveyor KCW/no

3020 North Post Road Indianapolis, Indiana 46226-0068 317-898-8282 317-899-8010 Fax

Engineering Surveying GIS • LIS Geology

CERTIFICATE OF COMPLETION AND COMPLIANCE

TO: HAMILTON COUNTY SURVEYOR

Schneider

Engineering

Corporation

RE: MERRIMAC SECTION 3

I hereby certify that:

- 1). I am a Registered Professional Engineer in the State of Indiana,
- 2). I am familiar with the plans and specifications for the above referenced subdivision,
- 3.) I have personally observed and supervised the completion of the Drainage Facilities for the above referenced subdivision, and
- 4.) To the best of my knowledge, information and belief, the Drainage Facilities within the subdivision have been installed and completed in conformity with all plans and specifications, with the exception of the lake facility within the legal drain still to be completed..

Signature:

Date: _1/9/97


Typed or Printed Name: Richard A. Henderson

Business Address: Schneider Engineering Corp. 3020 North Post Road, Indianapolis, IN 46226

Telephone: <u>898-8282</u>

Indiana Registration Number

900081

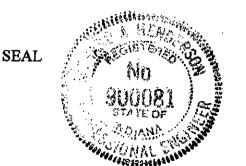



Fax (317) 776-9628 One Hamilton County Square Noblesville, Indiana 46060-2230

November 26, 1997

Mr. Milt Stewart Merrimac Corporation 254 E. Carmel Drive Carmel, IN. 46032

Dear Milt,

This letter is to notify your office that the enclosed sureties was released by the Hamilton County Board of Commissioners during their meeting of November 24, 1997.

Accompanying this letter you will find the following sureties.


SB - Fidelity and Deposit Company, Subdivision Bond for Merrimac Sec. 3 -Storm Sewers - \$ 80,270.00

LC - Bank One, Letter of Credit No. STO5447 for lake construction within the Charles Osborn and J.R. Collins #2 drain at Merrimac Sec. 3 - \$ 70,600.00

LC -Bank One, Letter of Credit No. STO5418 for Merrimac Sec. 3 - Erosion Control - \$ 41,225.00

Sincerely,

terry Il. Liston Hamilton County Surveyors Office

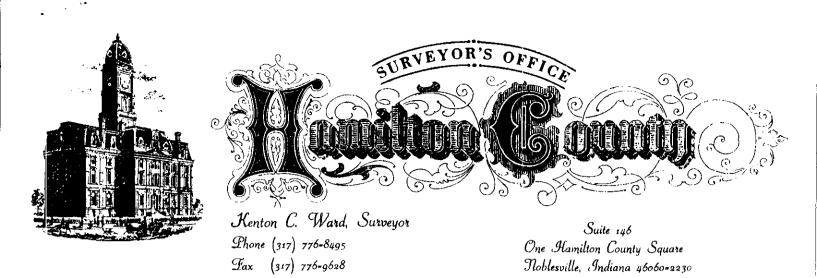

To: Hamilton County Drainage Board

December 16, 1997

8081

Re: Merrimac Drain - Sec. 3 Arm

Attached are as-builts, certificate of completion & compliance, and other information for Merrimac Sec. 3. An inspection of the drainage facilities for this section has been made and the facilities were found to be complete and acceptable.

During construction, changes were made to the drain which will alter the plans submitted with my report for this drain dated February 3, 1997. The changes are as follows: Str. 612-611 24"RCP shortened from 23' feet to 22' feet. Str. 610-609 24"RCP shortened from 185'feet to 180 feet. Str. 604-603 12"RCP shortened from 78' feet to 77' feet. Str. 603-602 12"RCP lengthened from 148' feet to 149' feet. Str. 602-601 12"RCP shortened from 156' feet to 151' feet. Str. 601-ex39 18"RCP shortened from 30' feet to 29' feet. Str. 624-623 12"RCP lengthened from 32' feet to 33' feet. Str. 622-620 18"RCP lengthened from 162' feet to 168' feet. Str. 619-618 18"RCP shortened from 190' feet to 188' feet. The corrected total of 6"SSD is 5,680' feet. The Lake will be used as the regional detention facility for the Osborn & J. R. Collins # 2.

The length of the drain due to the changes described above is now **8.082 feet**.

The non-enforcement was approved by the Board at its meeting on June 3, 1996 and recorded under instrument #9709720256.


The bond or letter of credit from Bank One, number ST05447 for the Lake, and ST05418 for erosion control; dated November 21, 1996 and December 20, 1996; in the amount of \$70,600.00, and \$41,225.00; was released November 24, 1997. The bond from Fidelity & Deposit Company of Maryland, dated November 22, 1996, in the amount of \$80,270.00 for storm sewers was released November 24, 1997.

I recommend the Board approve the drains construction as complete and acceptable.

Sincerely,

Kenton C. Ward, Hamilton/County Surveyor

KCW/slm

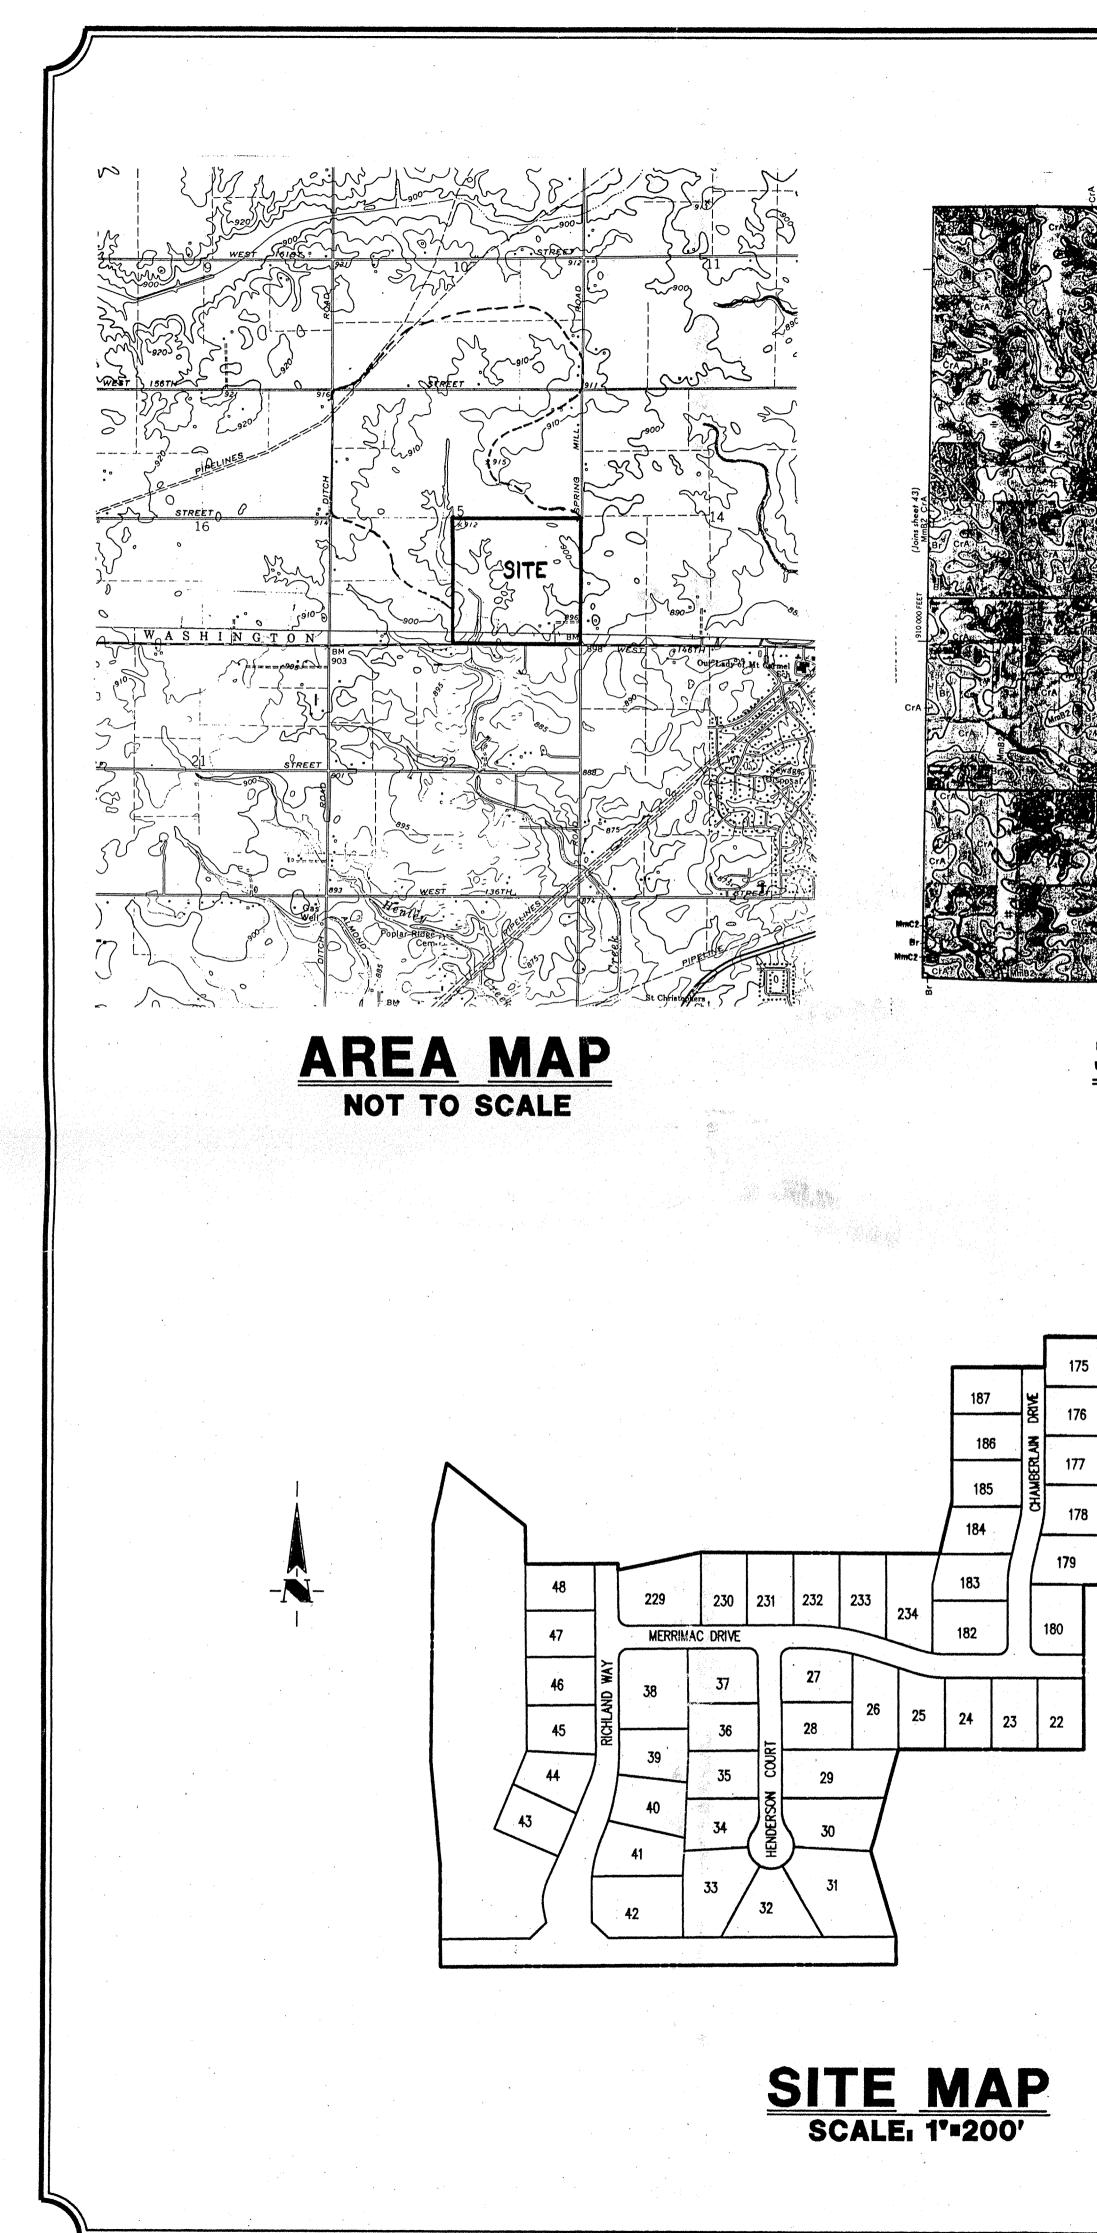

SOILS MAP NOT TO SCALE

- SOILS LEGEND: FnA Fox Loam, 0-2% slopes FnB2 Fox Loam, 2-6% slopes,
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(CONSTRUCTION PLANS) MERRIMAC SECTION 3


WESTFIELD, INDIANA WASHINGTON TOWNSHIP HAMILTON COUNTY, INDIANA **DEVELOPER:**

(317) 844-5111

Engineer:

SCHNEIDER ENGINEERING CORP. 3020 NORTH POST NOAD

SHEET NO

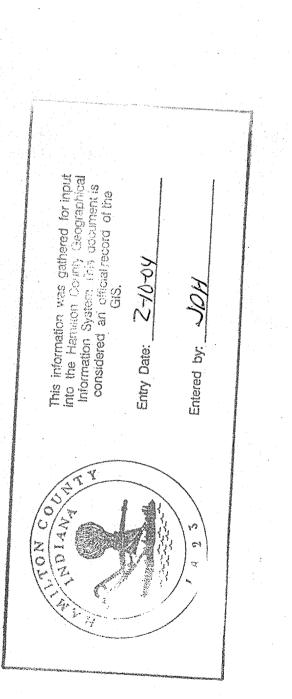

DATE CHECKED: ____

PROJECT MANAGER: _______

CHECKED BY:.

CS C101,C10 C103 C104 C201,C20 C301 C302 C401 C601,C6 C701 C702 C801,C80 C901 L101-10




SEC. 15-18N-3E

MERRIMAC CORP. 254 EAST CARMEL DRIVE CARMEL, INDIANA 46032

INDIANAPOLIS, INDIANA 46226

(317) 898-8282 FAX (317) 899-8010

	INDEX
0.	DESCRIPTION
	TITLE SHEET
02	SITE DEVELOPMENT PLANS
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	LAKE PLAN
03	STREET PLAN & PROFILES
	ENTRANCE PLAN
	INTERSECTION & CUL-DE-SAC DETAIL
	SANITARY SEWER PLAN & PROFILES
02	STORM SEWER PLAN & PROFILES
	WATER DISTRIBUTION SYSTEM
	WATER DISTRIBUTION DETAILS & SPECS.
02	GENERAL DETAILS
	SPECIFICATIONS
)2	LANDSCAPING PLANS

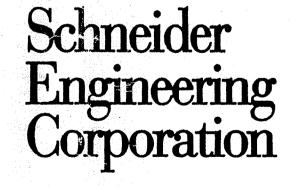

3020 North Post Road Indianapolis, Indiana 46226-0068 317-898-8282

CERTIFIED B

Engineering Surveying GIS • LIS Geology

317-899-8010 Fax A Partnered Entity with Bohlen, Meyer, Gibson & Associates, Incorporated

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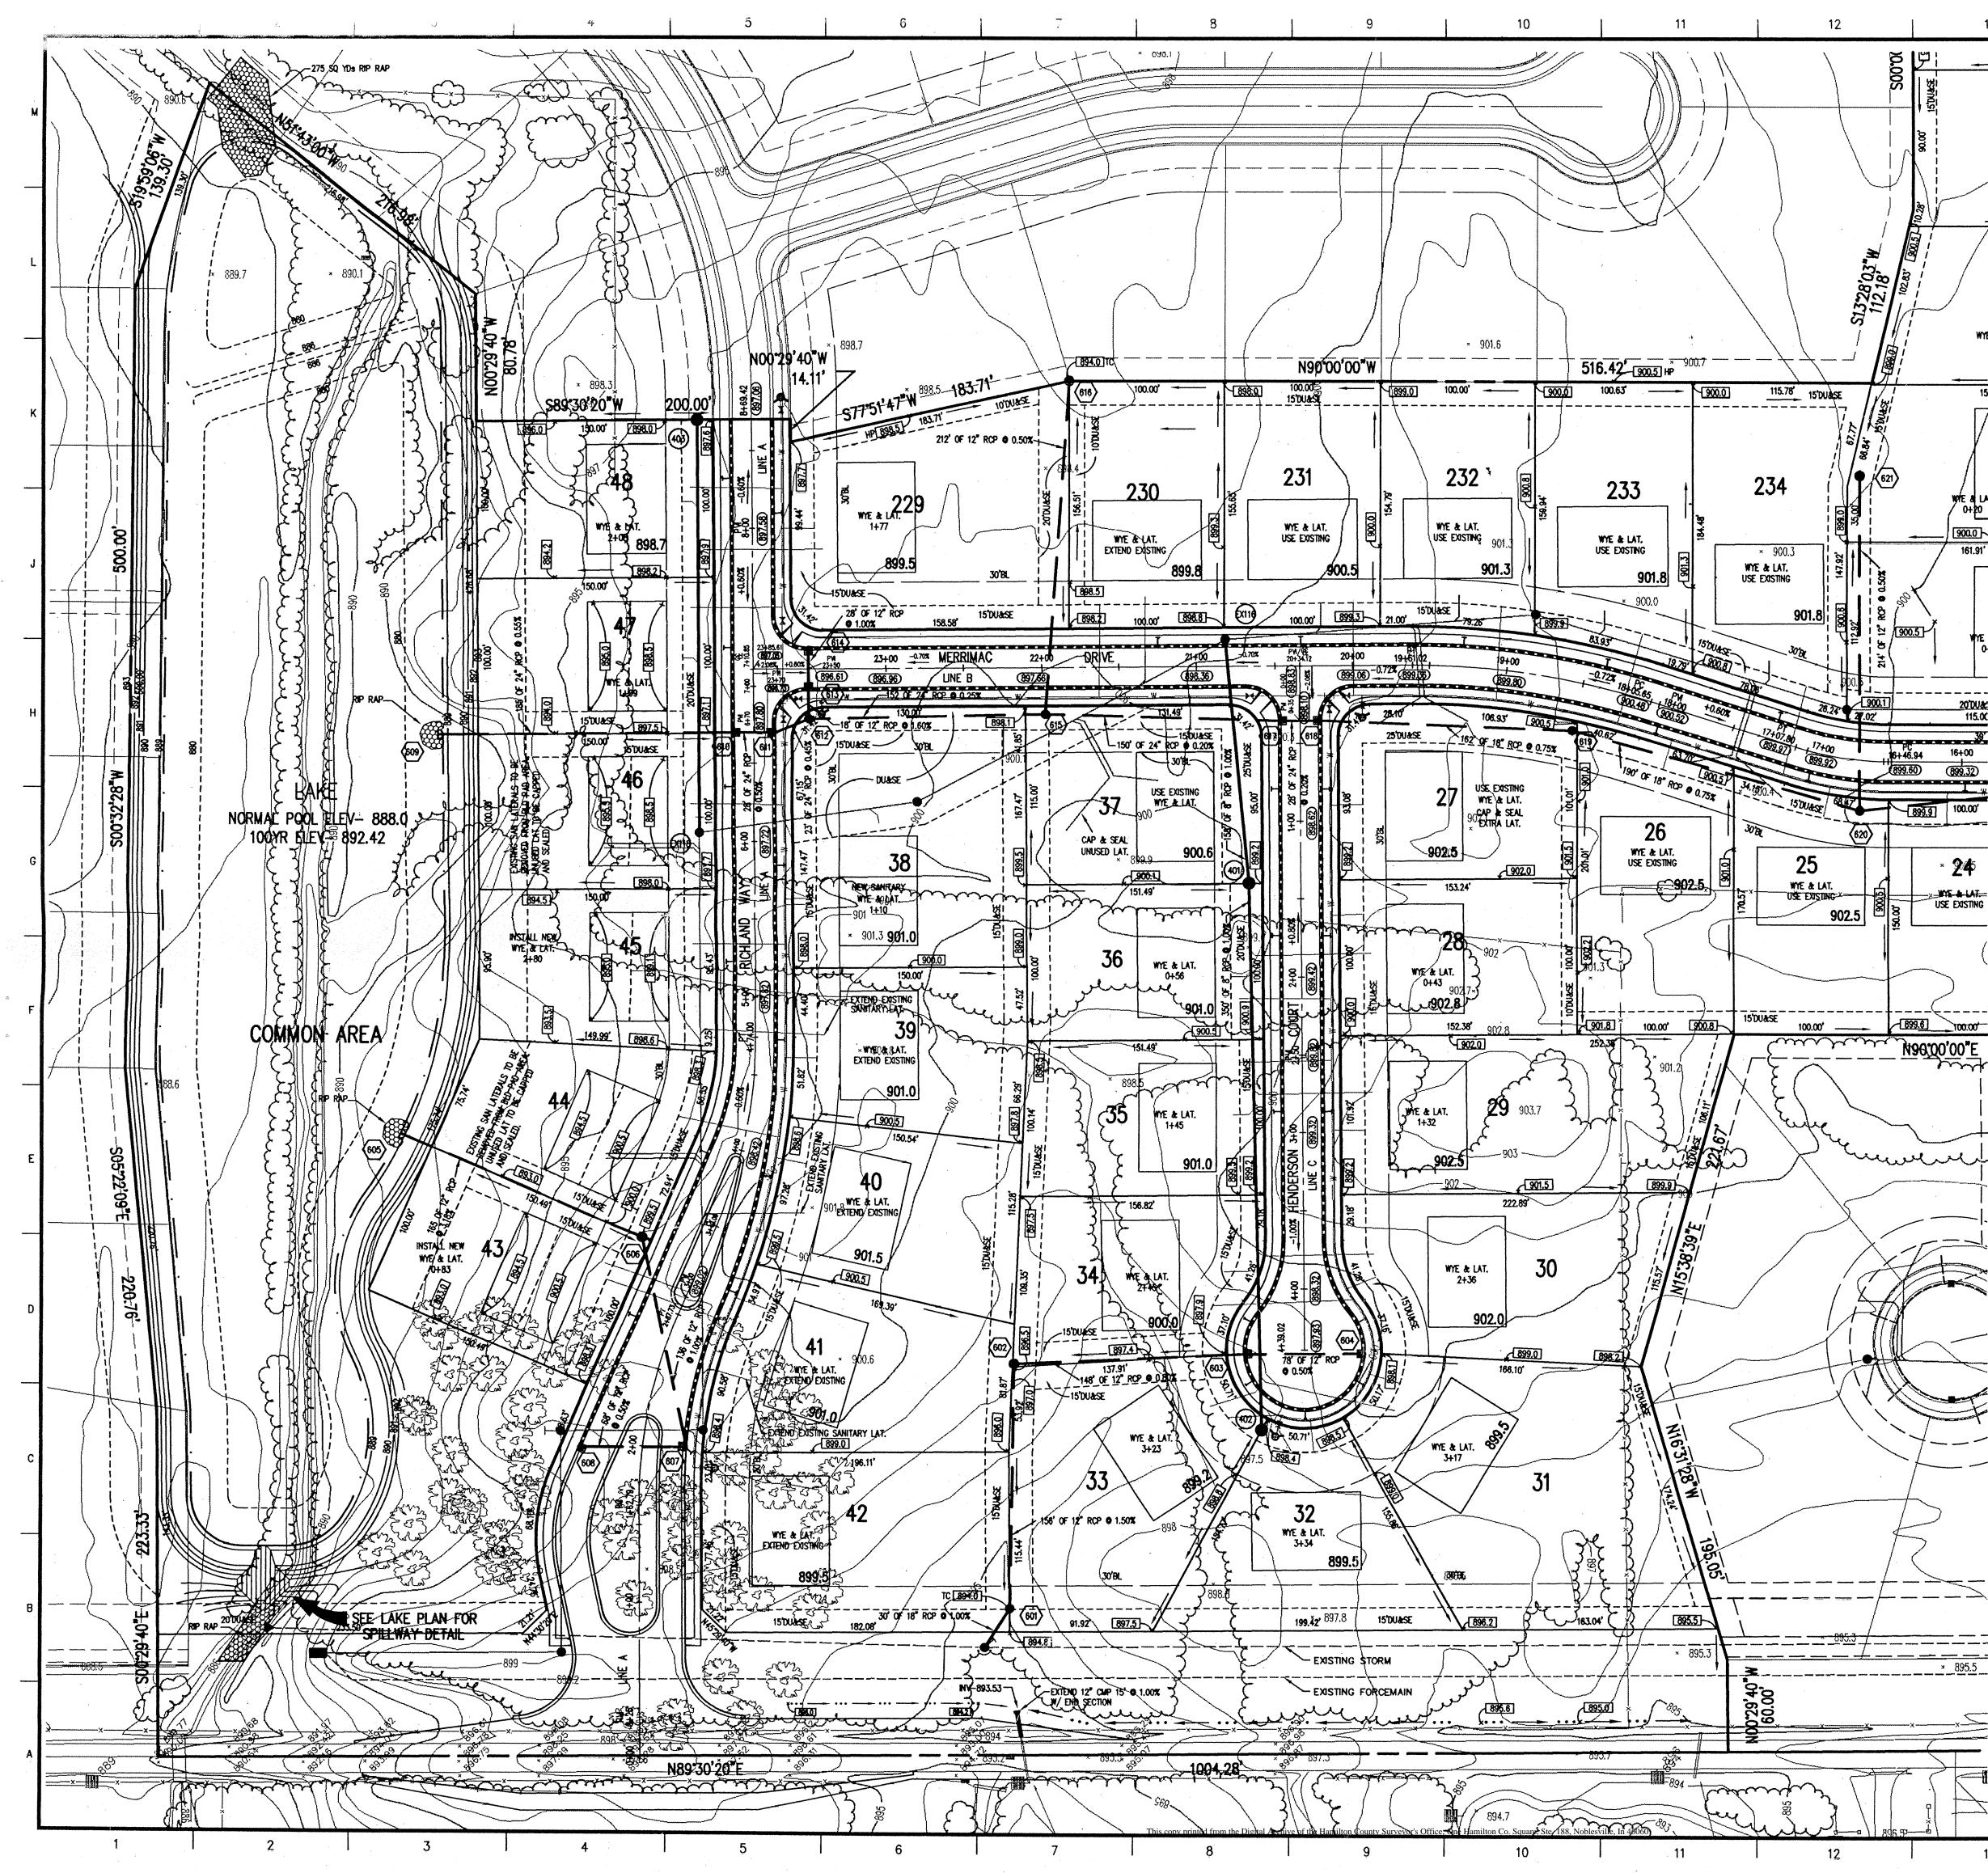
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STORM SEWER TABLE


STR #	STA BASE	LINE	OFFSET	LT/RT	TYPE	TC	INVERTS
601	0+95.37	٨	237.06	RT	BEEHIVE	894.00	885.97(SW), 890.89(N)
602	3+44.75	٨	210.02	RT	BEEHIVE	896.50	893.23(E,S)
603	4+41.73	C	38.91'	RT	CURB INLET	897.60	894.41(W,E)
604	4+41.73	C	38.91'	LT	CURB INLET	897.80	894.80(W)
605	3+24.49	٨	190.89'	LT	END SECTION		888.00(SE)
606	3+23.45	٨	40.89'	LT	NANHOLE	899.50	893.25(NW), 893.54(S)
607	2+03	A	27.82'	RT	CURB INLET	898.05	894.90(W,N)
608	1+95.47	٨	39.95'	LT	CURB INLET	897.74	804
609	6+69.71	٨	184.00'	LT	END SECTION		893.25(NW), 893.54(S) 894.90(W,N) 80*
610	6+70	A	14.00*	LT	CURB INLET	(ST.
611	8+70	٨	14.00'	RT	CURB N F		J.
612	23+50	B	32.00'	LT	· .	K	منازير (N), 889.25(E,W)
613	23+50	B	14.00	17			893.62(S,N)
614	23.50	B	14.00'			896.61	893.90(S)
615	21+98.03	B		20		898.40	889.64(E,W), 892.94(N)
616	21+80.69		0		BEEHIVE	897.00	894.00(S)
617	1.		X	ar	CURB INLET	898.10	889.94(W,E)
	EF			LT	CURB INLET	898.10	890.00(W), 890.50(E)
	K V		31.15'	LT	MANHOLE	900.70	891.71(W,E)
5	.0	8	32.56'	LT	MANHOLE	900.20	893.13(E,W), 894.33(N)
-	17+20.49	B	177.34'	RT	BEEHIVE	898.40	895.40(S)
622	15+02.92	B	14.00'	LT	CURB INLET	898.76	894.34(W), 894.59(N)
623	10+67	D	15.98'	RT	CURB INLET	898.32	894.90(S), 895.14(E)
624	10+67	D	15.98'	ĹT	CURB INLET	898.32	895.30(W)
EX39	-				MANHOLE	895.6	885.67(E,W, & NE)

◎ SANITARY SEWER TABLE

STR 🛔	STA BASEL	INE	OFFSET	LT/RT	TYPE	TC	INVERTS
401	1+39.78	C	32.26'	RT	MANHOLE	899.40	887.40(N), 887.50(S)
402	4+48.74	C	27.86'	RT	NANHOLE	898.60	891.00(N)
403	8+69.42	•	35.00'	IJ	MANHOLE	897.20	883.75(S), 883.85(N)
EX116					MANHOLE	898.60	885.82(S), 884.54(E, W)
EX118					MANHOLE	897.50	883.01(N), 882.60(S), 882.70(E)

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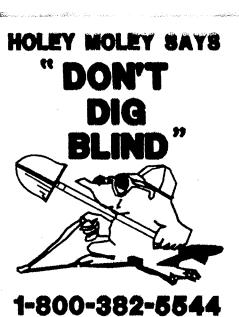


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ASSUMED NORTH SCALE : $1^{"}=50^{"}$

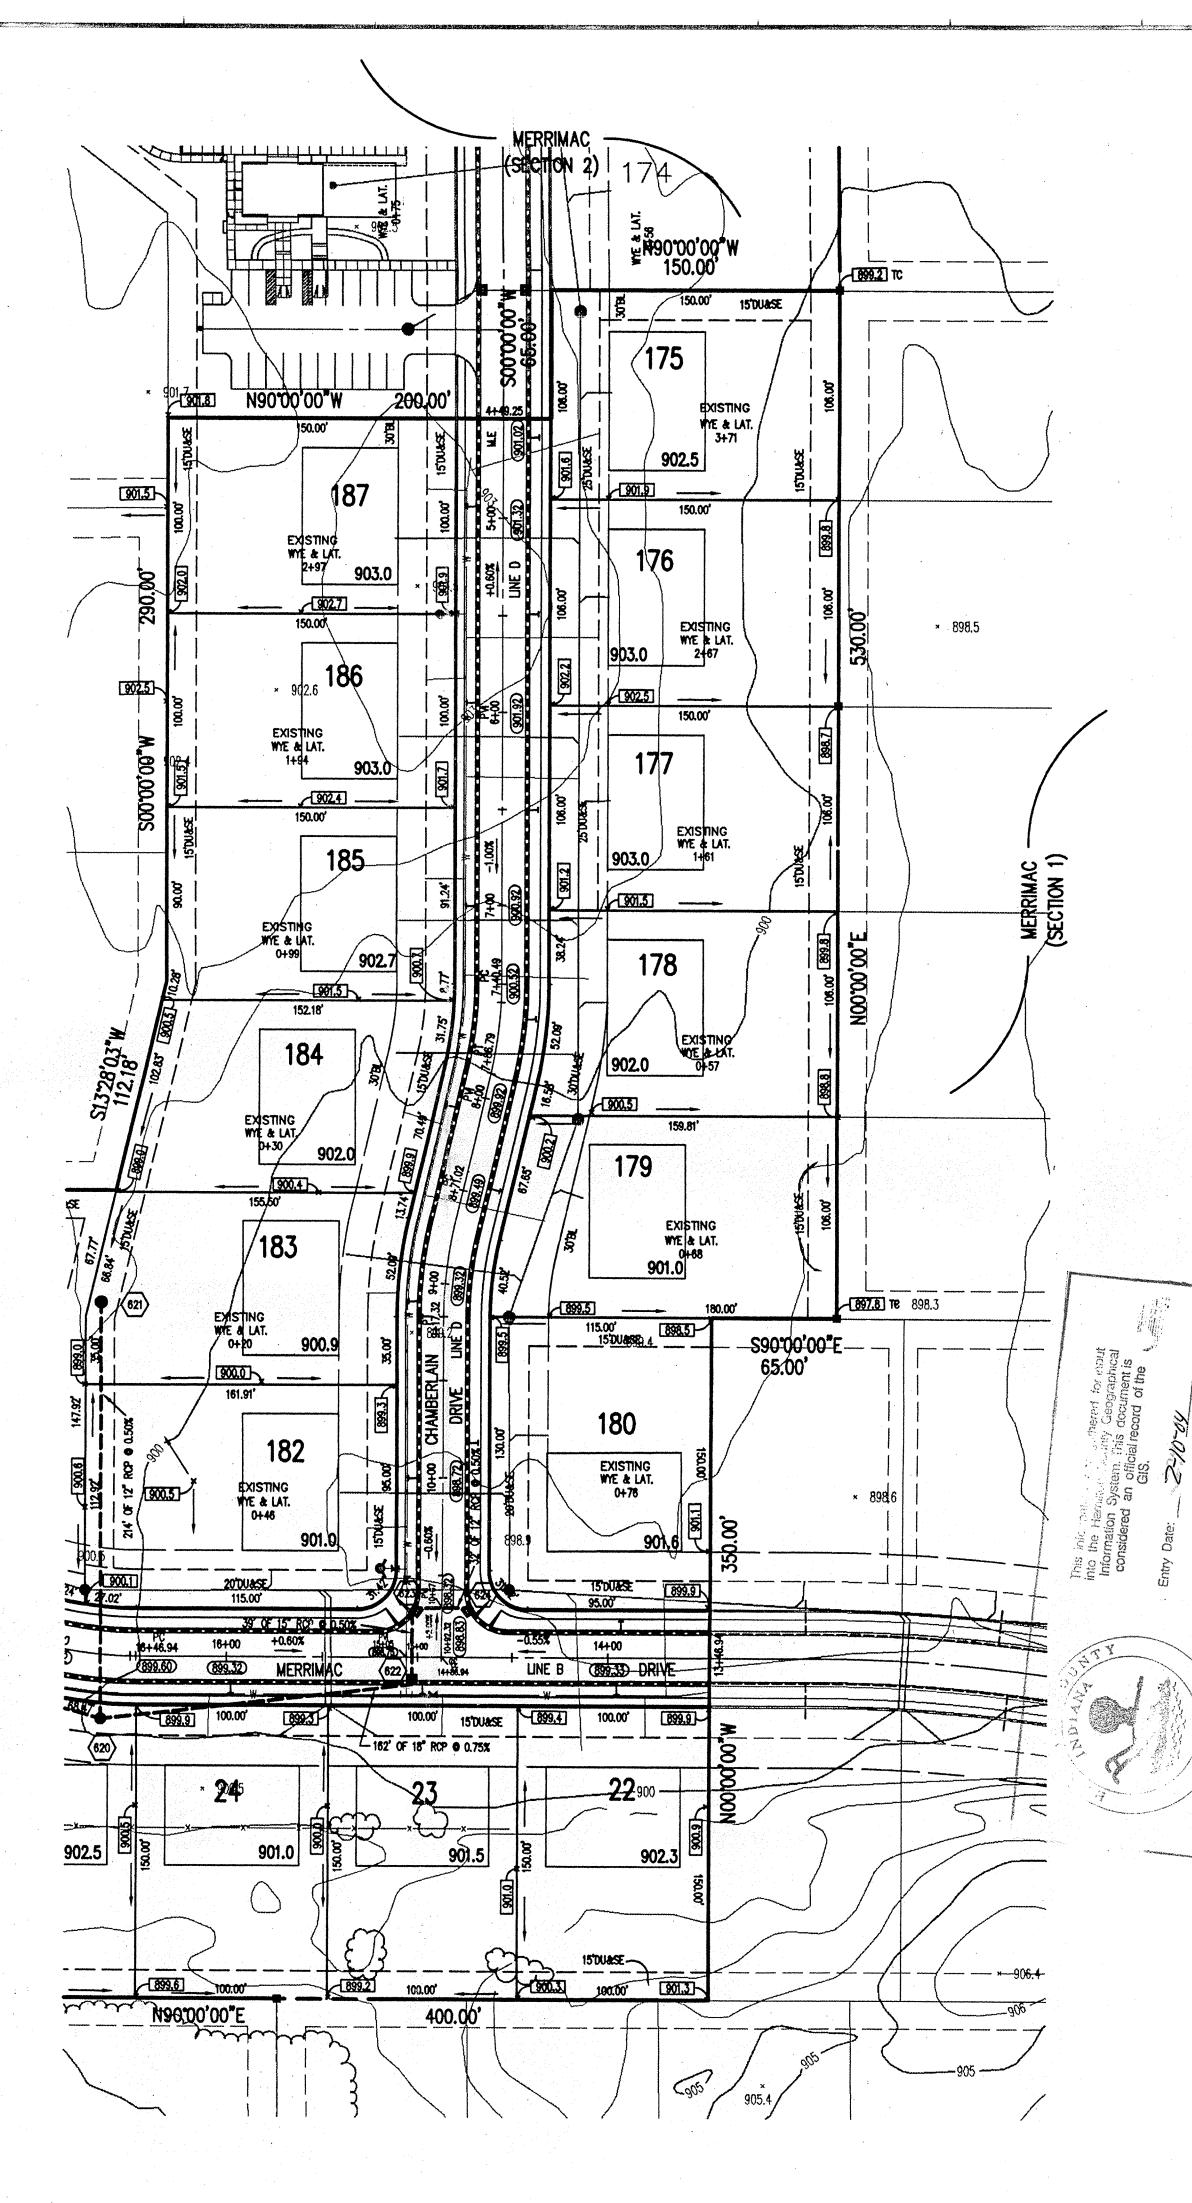

GENERAL NOTES:

ORADES.

. ALL GRADES AT BOUNDARY SHALL MEET EXISTING

UTILITIES AND CONDITIONS PERTAINING TO HIS PHASE OF WORK. IT SHALL ALSO BE THE SUBCONTRACTOR'S RESPONSIBILITY TO CONTACT

THE OWNERS OF THE VARIOUS UTILITIES FOR PROPER STAKE LOCATION OF EACH UTILITY BEFORE WORK IS STARTED. THE SUBCONTRACTOR SHALL NOTIFY IN WRITING THE OWNER OR THE

ENGINEER OF ANY CHANGES, OMISSIONS, OR ERRORS FOUND ON THESE PLANS OR IN FIELD BEFORE WORK IS STARTED OR RESUMED.

STANDARD SPECIFICATIONS FOR WESTFIELD

, INDIANA SHALL APPLY FOR ALL SANITARY SEWERS AND STORM SEWERS.

ANY PART OF THE SANITARY OR STORM SEWER

THE SIZE AND LOCATION OF EXISTING UTILITIES

TRENCHES RUNNING UNDER PAVED AREAS TO BE BACKFILLED WITH GRANULAR MATERIAL.

SHOWN ARE PER INFORMATION PROVIDED BY THE RESPECTIVE UTILITY COMPANIES. ALL UTILITY

COMPANIES SHOULD BY NOTIFIED PRIOR TO ANY

EXCAVATION FOR FIELD LOCATION OF SERVICES.

SERVICE WALKS SHALL BE NON-REINFORCED

EXPANSION JOINTS ARE TO BE PLACED AT ALL WALK INTERSECTIONS AND BETWEEN WALKS AND

PLATFORMS. SIDEWALK SCORES ARE TO BE

EQUALLY SPACED BETWEEN EXPANSION JOINTS. CONTRACTION JOINTS AND PERPENDICULAR

SIDEWALKS AT 5' INTERVALS OR LESS WITH A CONTRACTION JOINT EVERY 20' OR LESS.

8. 4' CONCRETE SERVICE WALK ACROSS FRONTAGE OF

9. SIDEWALKS CONSTUCTED ACROSS, AND IN CONJUNCTION WITH A RESIDENTIAL DRIVEWAY SHALL BE

EACH LOT TO BE CONSTRUCTED BY OTHERS.

TEMPORARY TRAFFIC CONTROL DURING CONSTRUCTION TO CONFORM TO APPLICABLE

1. ALL CONSTRUCTION ACTIVITY ON THIS SITE TO BE PERFORMED IN COMPLIANCE WITH APPLICABLE O.S.H.A. STANDARDS FOR WORKER SAFETY.

3. REMOVE AND BACKFILL ALL AREAS WHERE ANY FIELD THE CROSSES PROPOSED

HOUSE PADS. ALL FIELD TILES INTERCEPTED TO BE PERPETUATED INTO STORM SEWER SYSTEM OR LAKE.

12. CONTRACTOR SHALL MINIMIZE DAMAGE TO

LOCAL AND STATE STANDARDS.

AT LEAST 6" THICK

EXISTING TREES.

Revisions

CONCRETE 4" THICK AND 4' IN WIDTH. CURB RAMPS FOR THE DISABLED SHALL BE REQUIRED WITHIN THE PUBLIC RIGHT OF WAY AND SHALL CONFORM

WITH CURRENT SPECIFICATIONS ESTABLISHED BY THE AMERICAN DISABILITIES ACT (ADA), SECTION (4,7) "CURB RAMP"

2. IT SHALL BE THE RESPONSIBILITY OF EACH SUBCONTRACTOR TO VERIFY ALL EXISTING

CALL TOLL FREE **1-800-428-5200** FOR CALLS OUTSIDE OF INDIANA PER INDIANA STATE LAW IS-69-1991.

IT IS AGAINST THE LAW TO EXCAVATE WITHOUT NOTIFYING THE UNDERGROUND LOCATION SERVICE TWO (2) WORKING DAYS BEFORE COMMENCING WORK.

<u>BENCH MARK</u> U.S.G.S. 93 RHP (1951)

U.S.G.S. 95 KHP (1951) BRONZE TABLET SET IN CONCRETE POST, LOCATED ON THE SOUTH SIDE OF 146th STREET, APPROX. 25' WEST OF THE CENTERLINE OF DITCH ROAD. (ELEVATION = 903.373)


UTILITY OWNERS


SANITARY SEWERS AND WATER HAMILTON WESTERN UTILITIES 1350 GRAYHOUND PASS CARMEL, IN. 46032 BEAU WILFONG 848-6882 GAS INDIANA GAS CO. n U 505 WEST CR. 125 S. LEBANON, IN. 46052 JEFF AUTRY (317) 482-6456 ELECTRIC **PSI ENERGY** 2 P.O. BOX 876 R CARMEL, IN. 46032 L MARK LA BARR 581.3041 3 PHONE AMERITECH \mathbf{C} Ш 5858 N. COLLEGE AVE. S INDPLS. IN. 46220 JANE MESSENGER 252-4275 CATV Σ JONES INTERCABLE 2 516. E. CARMEL DR. CARMEL, IN. 46023 THIS DRAWING AND THE IDEAS, DESIGNS AND CONCEPTS CONTAINED HEREIN ARE THE EXCLUSIVE INTELLECTUAL PROPERTY OF SCHWEDER ENGINEERING CORPORATION AND ARE NOT TO BE USED OR REPRODUCED IN WHOLE OR IN PART, WITHOUT THE WRITTEN CONSENT OF SCHWEDER ENGINEERING CORPORATION. 0 $\mathbf{\Omega}$ 844-8877 © 1995, Schneider Engineering Corporation S LEGEND Schneider Existing Storm Sewer . . . Engineering New Storm Sewer Corporation Existing Sanitary Sewer New Sanitary Sewer 3020 North Post Road Engineering Indianapolis, Indiana 46226–0068 Existing Contour Surveying GIS • LIS Existing Elevation 000.0 317-898-8282 Geology (000.00) New Pavement Elevation 317-899-8010 Fax 000.00 All Other Finish Elevations A Partnered Entity with Bohlen, Meyer, Gibson & Associates, Incorporated **Corrected Elevations** . (000.00) 600 Storm Structure Number MERRIMAC CORP. \bigcirc Sanitary Structure Number MERRIMAC SECTION 3 Flow Arrow WESTFIELD, INDIANA Denotes Elevation 000.0 Approximate Pad Size SITE DEVELOPMENT PLAN- EAST PART _____ Subsurface Drain w/4" Lateral Connection Project No. 1045.03 Date Drawn Approv. 2/18/96 BGG Swale Elevation (Flow Line) Sheet No. **Computer** Files 03C101 XREF-- 1045T0P0 104502PL 104503PL C102FEB 18 1997 UFFICE OF HAMILIUN COUNTY SURVEYOR 14 15

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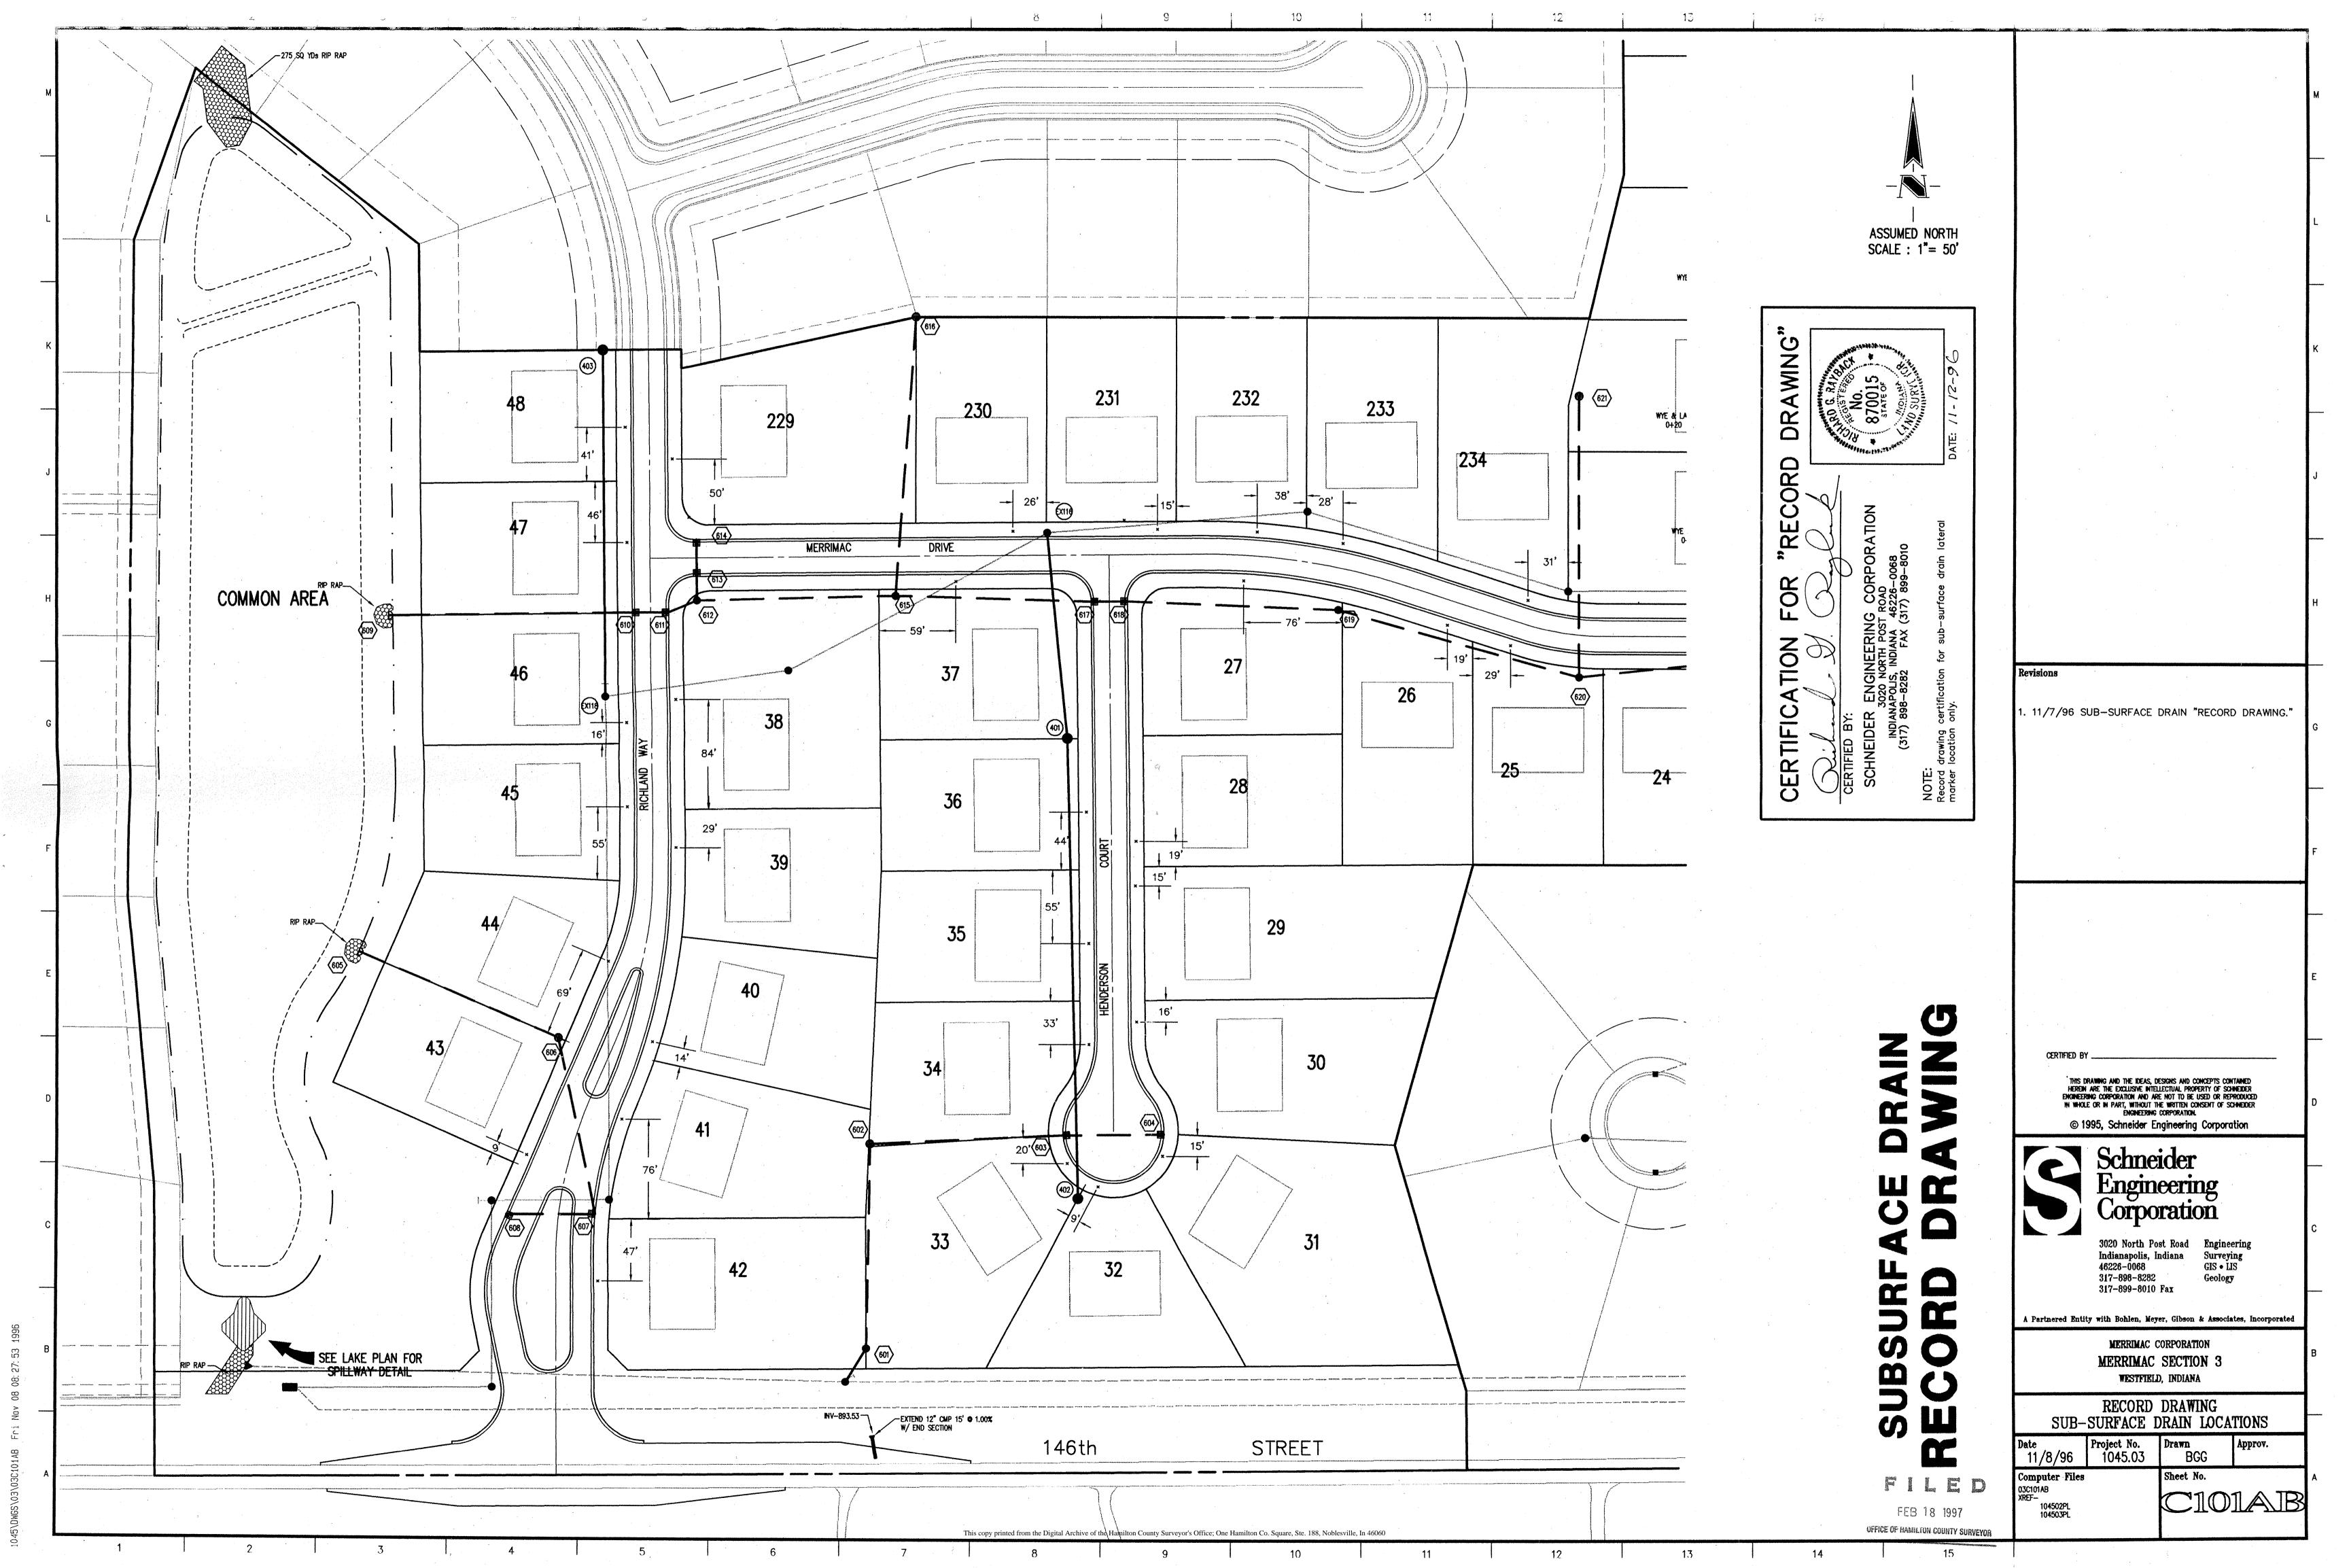
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 STR. No. 606 6801 MANHOLE -----STR. No. 607 12 -----CURB INLET C801 ------12 C801 CURB INLE STR. No. EX 39 MANHOLE 910 905 £899.97} £898.25} {**897.82**} TC- 899.5-TC- 898.05-(895.70) TC- 895.6-TC- 897.74-900 EXIST. GRADE GRANULAR BACKFI 895 GRADE INV- 895.24(E) - INV- 894.9(W) {894.30} 895.423 {894.30} 24" RCP (W) -INV- 885.67 - INV- 893.54(SE) (893.92) 890 INV- 893.25(NW) {893.92} 15" RCP (E) -INV- 885.67 EXISTING 18" RCP STUB INV- 885.67 (NE) 885 -INV- 888.00(SE) {888.09} {885.70(W)} 11/V-/688.67(UE {885.70(E)} 880 (885.70(NE) 160 2007 875 *co **′O** 69" 68' of 12" RCP 0.28% 136' of 12" RCP (CLASS 3) 9 T.00% (3.53%) 165' of 12" RCP (CLASS 3) @ 3:182 (CLASS 3) © 0.50% (1.62%) م ا 870 IR. No. EX 39 Anhole <u>I</u> 25 25 25 S R R S




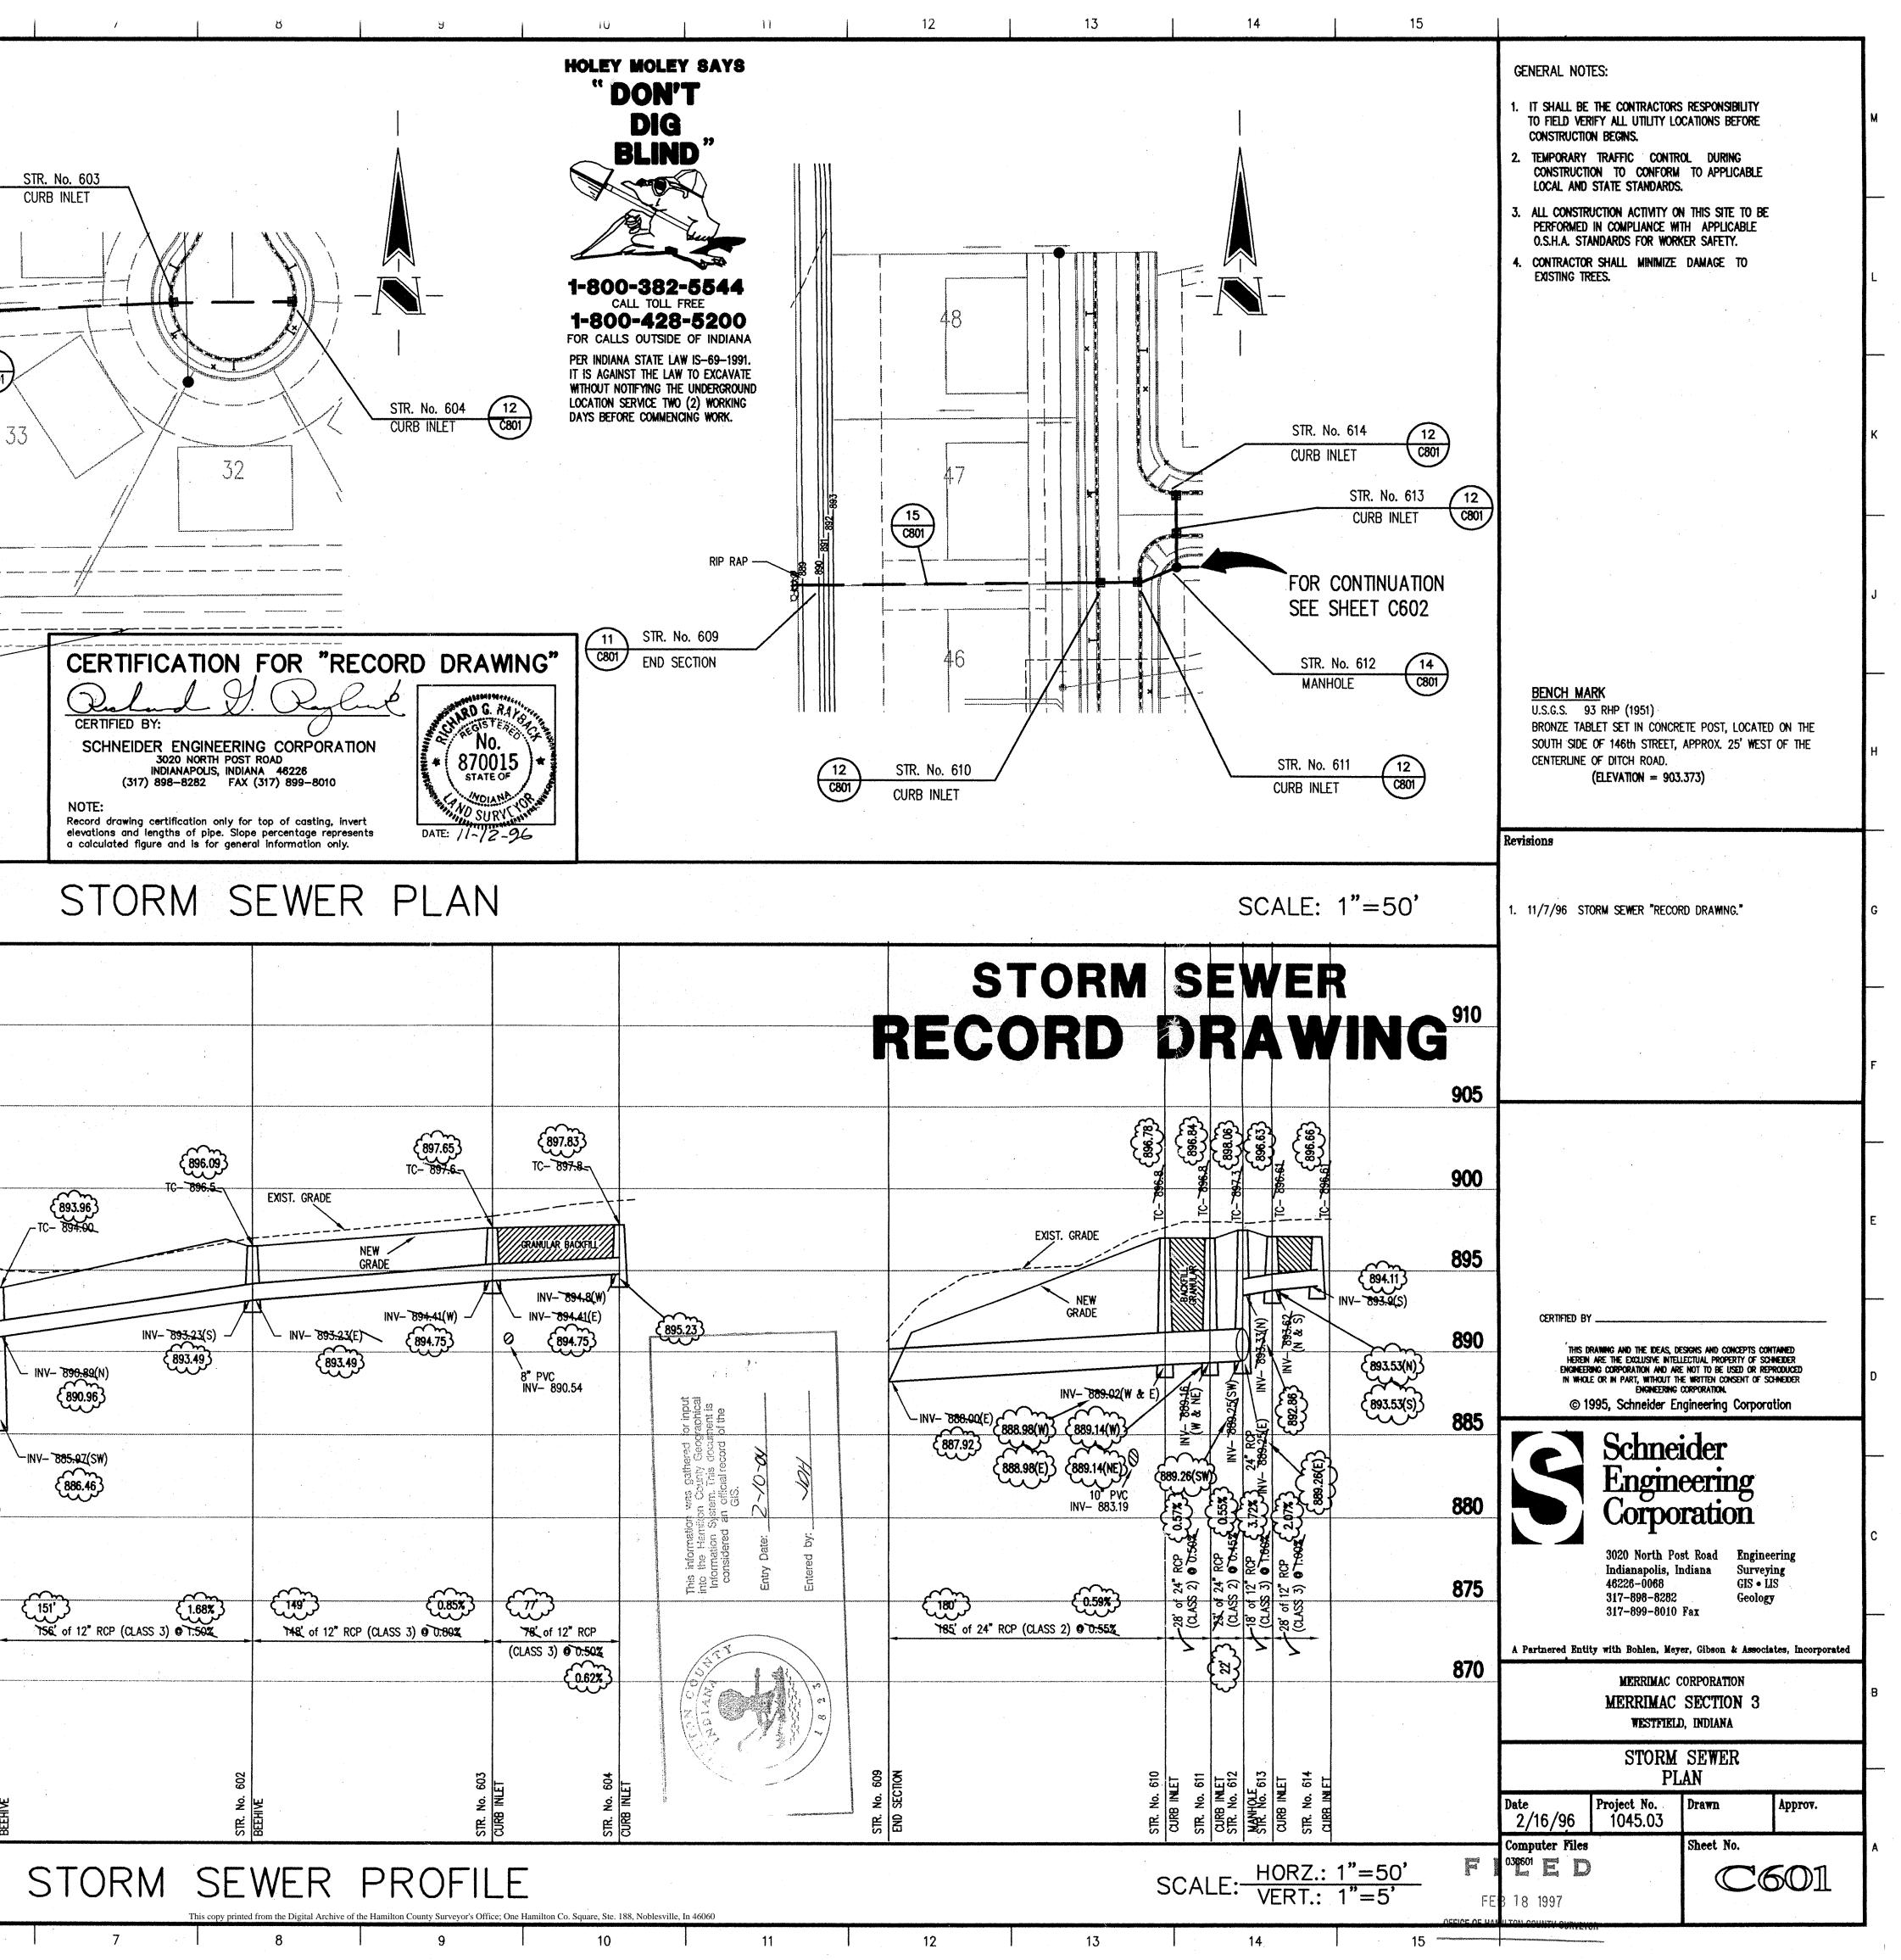

GENERAL NOTES: HOLEY MOLEY SAYS 1. IT SHALL BE THE CONTRACTORS RESPONSIBILITY TO FIELD VERIFY ALL UTILITY LOCATIONS BEFORE DONT CONSTRUCTION BEGINS. DIG 2. TEMPORARY TRAFFIC CONTROL DURING CONSTRUCTION TO CONFORM TO APPLICABLE BLIND LOCAL AND STATE STANDARDS. ALL CONSTRUCTION ACTIVITY ON THIS SITE TO BE PERFORMED IN COMPLIANCE WITH APPLICABLE O.S.H.A. STANDARDS FOR WORKER SAFETY. CONTRACTOR SHALL MINIMIZE DAMAGE TO EXISTING TREES. 1-800-382-5544 CALL TOLL FREE 1-800-428-5200 FOR CALLS OUTSIDE OF INDIANA PER INDIANA STATE LAW IS-69-1991. IT IS AGAINST THE LAW TO EXCAVATE WITHOUT NOTIFYING THE UNDERGROUND LOCATION SERVICE TWO (2) WORKING DAYS BEFORE COMMENCING WORK. 12 STR. No. 624 C801 CURB INLET nsicered L 心口的语言 Erry Date: Z-//-Entered by: BENCH MARK U.S.G.S. 93 RHP (1951) STR. No. 622 12 CURB INLET C801 BRONZE TABLET SET IN CONCRETE POST, LOCATED ON THE SOUTH SIDE OF 146th STREET, APPROX. 25' WEST OF THE CENTERLINE OF DITCH ROAD. (ELEVATION = 903.373)Revisions SCALE: 1"=50' 11/6/96 STORM SEWER "RECORD DRAWING." 910 {900.45} 905 { 897.46 } TC- 900.2--TC- 898.4 EXIST. GRADE 900 ----BACKFIL NEW GRADE 895 -18" RCP -INV- 895.4(S) TINV- 893.13 ↓ (NW & NE) INV- 894.33(N)-£894.56} (892.95(NW)) (892.95(NE)) (893.95(N)) 890 THIS DRAWING AND THE IDEAS, DESIGNS AND CONCEPTS CONTAINED HEREIN ARE THE EXCLUSIVE INTELLECTUAL PROPERTY OF SCHNEIDER ENGINEERING CORPORATION AND ARE NOT TO BE USED OR REPRODUCED IN WHOLE OR IN PART, WITHOUT THE WRITTEN CONSENT OF SCHNEIDER ENGINEERING CORPORATION. © 1995, Schneider Engineering Corporation 885 Schneider **Engineering** Corporation 880 Engineering 3020 North Post Road Surveying GIS • LIS ndianapolis. Indiana 875 46226-0068 317-898-8282 Geology 0.29% 317-899-8010 Fax 214' of 12" RCP (CLASS 3) 0 0.50% Partnered Entity with Bohlen, Meyer, Gibson & Associates, Incorpora **STORM SEWER** 870 MERRIMAC CORPORATION MERRIMAC SECTION 3 **RECORD DRAWING** WESTFIELD, INDIANA STORM SEWER PLAN Project No. 1045.03 Approv. Drawn 2/16/96 Sheet No. Computer Files Gent SCALE: HORZ.: 1"=50' VERT.: 1"=5' C602B 18 1997 OFFICE OF HAMILTON COUNTY SURVEYO 15 13 14

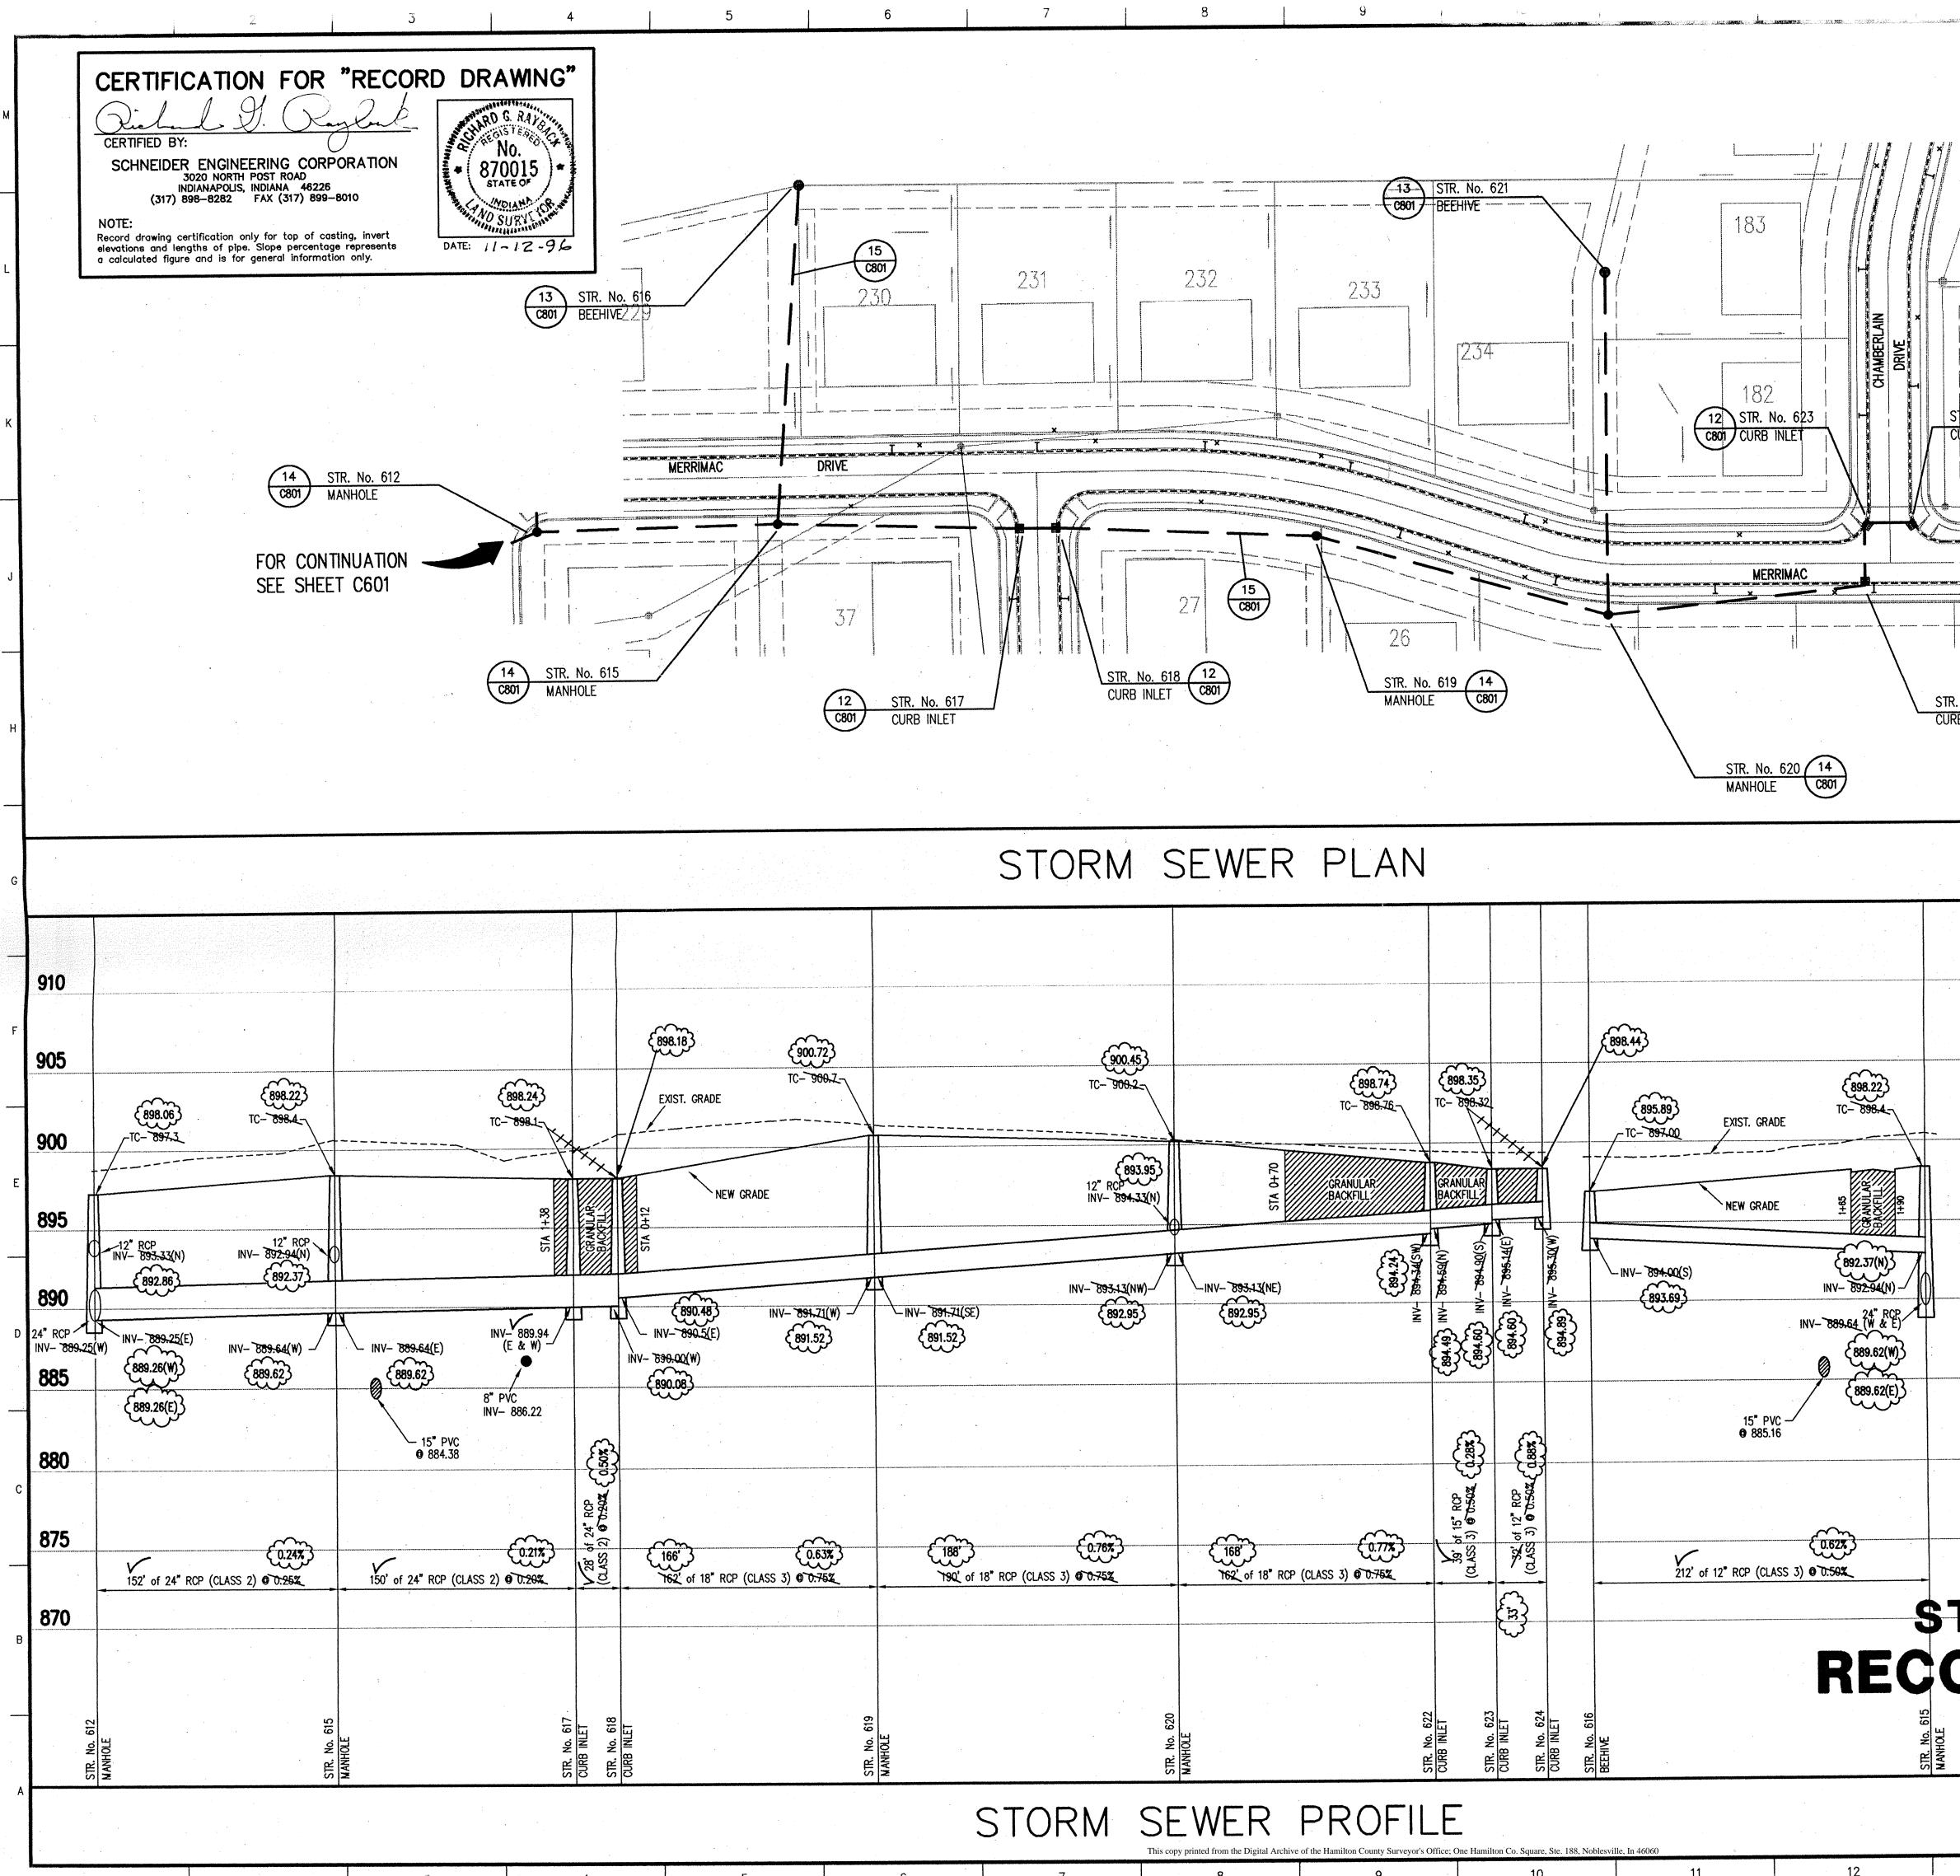

CERTIFICATION FOR "RECORD DRAWING" RD G. CERTIFIED BY: • (870015) • (870015) • (870015) • (870015) SCHNEIDER ENGINEERING CORPORATION 3020 NORTH POST ROAD INDIANAPOLIS, INDIANA 46226-0068 (317) 898-8282 FAX (317) 899-8010 NOTE: Record drawing certification for sub—surface drain lateral marker location only. DATE: 11-12-96 1 2 3

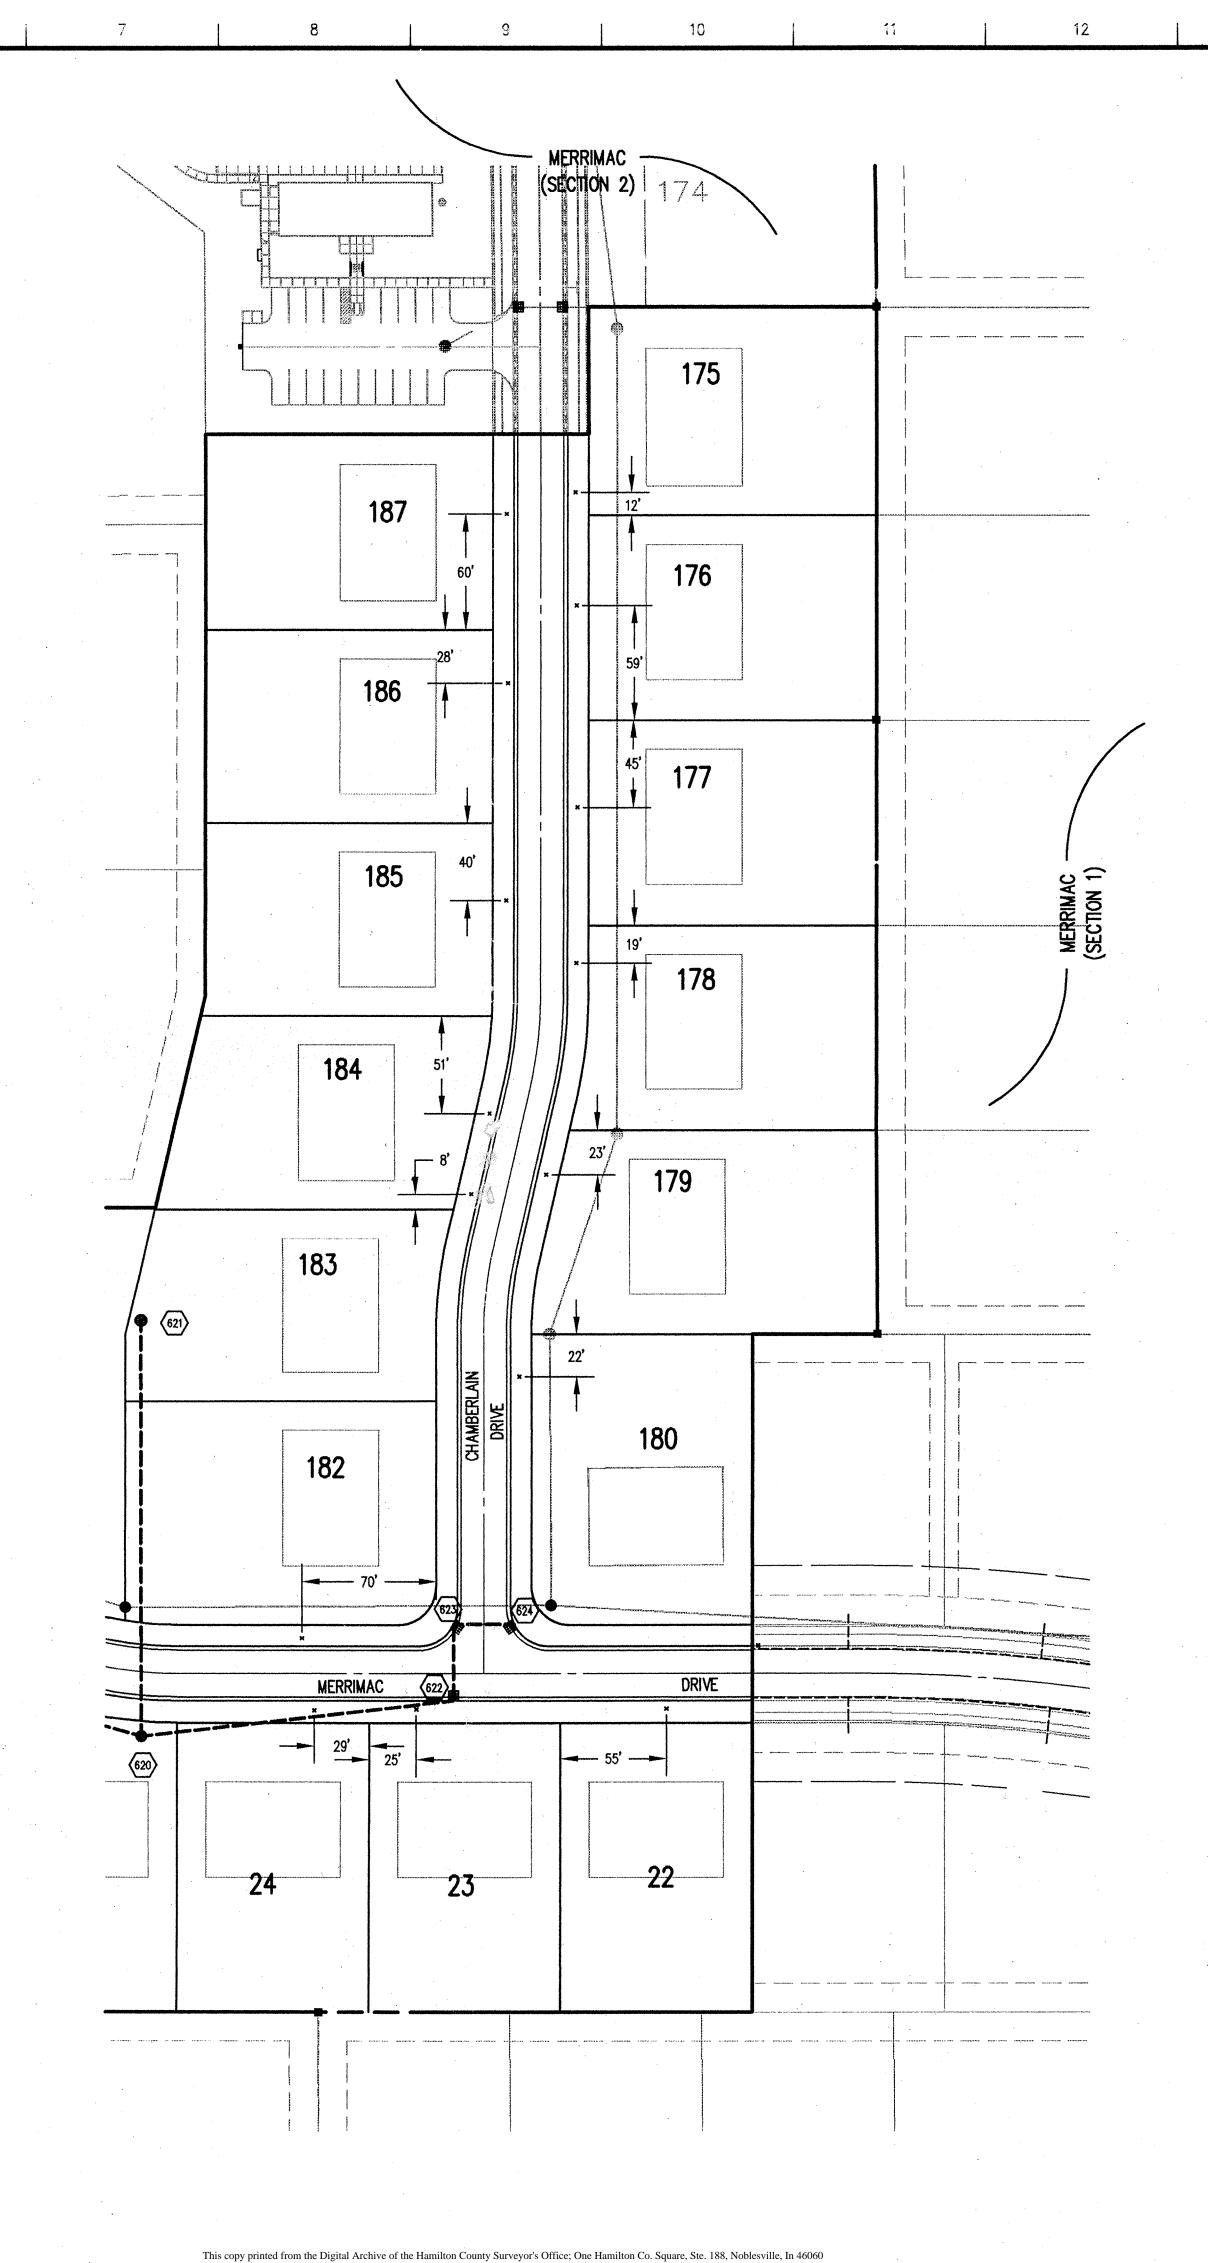

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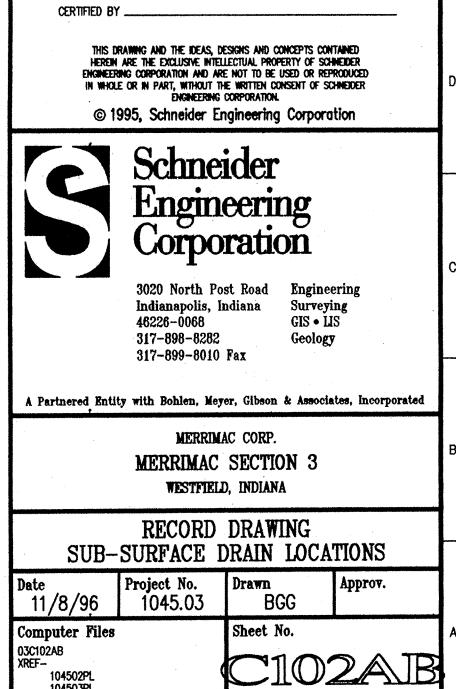
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ASSUMED NORTH SCALE : 1"= 50'

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Revisions

11/7/96 SUB-SURFACE DRAIN "RECORD DWG."



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